D2 Custom Homes

Contact List

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MUNICIPAL ADDRESS DRAWING NAME

Brant, ON DRAWING NO.

Cover Page

GENERAL NOTES

- THE ONTARIO BUILDING CODE, LATEST ADDITION, SHALL BE THE BASIS FOR ALL DESIGN AND CONSTRUCTION FOR THIS PROJECT.
- THE CONTRACTOR SHALL FIELD VERIFY ALL RELEVANT CONDITIONS AND DIMENSIONS PRIOR TO COMMENCEMENT OF DEMOLITION AND NOTIFY THE ARCHITECTURAL DESIGNER \$ SUPPORTING CONSULTANTS OF ANY DISCREPANCIES WITH THE DRAWINGS PRIOR TO COMMENCEMENT OF WORK.
- DEMOLITION WORK SHALL BE EXECUTED IN A ORDERLY AND CAREFUL MANNER. ALL DEMOLISHED MATERIALS UNLESS OTHERWISE NOTED SHALL BECOME THE PROPERTY OF THE CONTRACTOR FOR DISPOSAL OFF SITE AT HIS EXPENSE, IN A LEGAL MANNER.
- THE WORK INVOLVED HEREIN SHALL BE THE ENTIRE RESPONSIBILITY OF THE CONTRACTOR, WHO SHALL ENSURE THAT SUCH WORK IS PROPERLY CARRIED OUT BY HIS FORCES OR HIS SUBCONTRACTORS. THE CONTRACTOR SHALL CONFIRM FOR HIMSELF THAT ALL ITEMS ARE COVERED.
- REFER TO CONSULTANT'S DRAWINGS FOR EXTENT OF MECHANICAL WORK. COORDINATE
- DETWEEN ALL DISCIPLINES.

 OWNERS SHALL REMOVE PRESERVED ITEMS (I.E. PLAQUES, PICTURES) OFF WALLS \$
 FURNITURE PRIOR TO COMMENCEMENT OF CONTRACT WORK. THIS CONTRACTOR TO COORDINATE W/ OWNER FOR EXTENT OF WORK
- THE FLOOR PLAN AS SHOWN IS A SCHEMATIC REPRESENTATION OF THE BUILDING AND IS FOR REFERENCE ONLY. A COMPLETE AND THOROUGH ON SITE INSPECTION IS TO BE CARRIED OUT PRIOR TO SUBMITTING TENDER.
- REMOVE \$ SALVAGE ALL COPPER GUTTERS, DOWNPIPES, \$ FLASHING.

GENERAL NOTES

- DIMENSIONS FOR INTERIOR PARTITION WALLS ARE FROM FINISHED FACE TO CENTRE OF STUD DIMENSIONS FOR EXTERIOR WALLS TO EXTERIOR FACE OF WOOD STUD OR FINISHED FACE
- ALL DIMENSIONS TO AN EXISTING WALL ARE TO FINISHED FACE. CONTRACTOR TO SITE VERIFY EXISITING CONDITIONS AND REPORT DISCREPTANCIES.
- DISPOSE OF REMOVED ITEMS IN A LAWFUL MANNER IN ACCORDANCE WITH MUNICIPAL
- STANDARDS.
- CARE SHALL BE TAKEN TO MINIMIZE DAMAGE TO ABUTTING PROPERTIES. PROVIDE APPROVED FASTENING DEVICES INCLUDING JOIST HANGERS. MAIN BATHROOM TO HAVE STUD BLOCKING FOR FUTURE INSTALLATION OF GRAB BARS.
- VENT ALL FAMS TO EXTERIOR INCLUDING FAMS FOR DRYER.
- PROVIDE 1/2" CEMENT BOARD INSTEAD OF GYSPUM BOARD IN ALL SHOWERS \$ TUBS.

OPENINGS \$ HEADERS

- MOUNT ALL WINDOWS TO ALIGN WITH EXTERIOR DOORS UNLESS NOTED OTHERWISE ON
- HEADERS TO BE 2-2XIO" WITH I JACKSTUD + I KING STUD UNLESS NOTED OTHERWISE. PROVIDE 3-1/2" \times 3-1/2" \times 1/4" STEEL BRICK ANGLE TYP. FOR ALL OPENINGS IN MASONRY

GUARD RAILS \$ RAILINGS

- ALL INTERIOR STAIR RAILINGS TO BE 36"H AS PER OBC 2012.
- PROVIDE 36"H CONSTRUCTION GUARD AT ANY DOOR 24"ABOVE GRADE OR FLOOR
- OPENING DURING THE COURSE OF CONSTRUCTION. ALL STAIRS \$ RAILS TO COMPLY WITH OBC 9.8.7.

ROOF \$ ATTIC SPACE

PROVIDE DURAFLO 50 ROOF VENTS TO 1:300 RATIO AS PER OBC 2012

UP TO MAX SPAN OF 8'-0" OR UNLESS ANNOTATED OTHERWISE.

- PROVIDE PRE PAINTED METAL VALLEYS AND EAVES STARTER.
- PROVIDE STEP FLASHING AS REQUIRED.
- PROVIDE KITCHEN \$ BATH EXHAUSTS AS REQUIRED
- PROVIDE (1) BASE ROW ULTA BASE SHEET.
 ENSURE MIN. 2-1/2" AIR SPACE IS MAINTAINED BETWEEN INSULATION \$\(\psi\) UNDERSIDE OF
- SHEATHING; INSTALL DEPRESSIONS AS REQUIRED. NO FIRE STOP REQUIRED IN ATTICS LESS THAN 3,230 S.F. AND NO DIMENSIONS GREATER THAN 65'-1" AS PER DRAWINGS

HEATING, VENTILATION \$ A/C

- REFER TO HEAT LOSS DESIGN \$ ASSESSMENTS AND ENERGY EFFICIENCY DESIGN SUMMARY.
- VENT DRYER \$ ALL EXHAUST FANS TO EXTERIOR.
- TYPE OF HEATING SYSTEM: FORCED AIR + AIR CONDITIONING

SMOKE \$ C.O. DETECTORS

- SMOKE DETECTORS ARE TO BE PROVIDED AS PER OBC 9.10.19.3. CARBON MONOXIDE DETECTORS ARE TO BE PROVIDED AS PER OBC 9.33.4.2.


CONTRACTOR TO SITE VERIFY ANY STEP FOOTINGS IN THE EXISTING FOUNDATION WALL ADJACENT OT THE ADDITION \$ REPORT FINDINGS TO ARCHITECTURAL DESIGNER FOR

- REVIEW OF UNDER PINNING IF NECCESSARY. PROVIDE 4" PERFORATED WEEPING TILE WITH CLOTH COVER CONNECTED TO SEALED SUMP
- PIT C/W PUMP. PROVIDE MIN. 6'
- COVEREAGE OF CLEAR STONE

SITE PLAN NOTES

REFER TO TOPOGRAPHICAL SURVEY FOR ALL SITE STATISTICS \$ GRADING.

WALL ASSEMBLIES

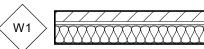

TYPICAL STONE VENEER WALL 3 1/2" LINEAR STONE VENEER 1" AIR SPACE TYVEK BUILDING WRAP 5/8" PLYWOOD SHEATHING 2X6 WOOD STUDS @ 16" O.C. WITH (R24) ROCK WOOL BATT INSULATION 6 MIL. POLY V.B. 1/2" GYPSUM WALL BOARD



TYPICAL SIDING WALL
PRE-FINISHED SIDING (REFER TO ALL) ELEVATIONS FOR SIDING TYPE/STYLE) 1X3" STRAPPING AS NEEDED TYVEK BUILDING WRAP 5/8" PLYWOOD SHEATHING 2X6 WOOD STUDS @ 16" O.C. WITH (R24) ROCK WOOL BATT INSULATION 6 MIL. POLY V.B. 1/2" GYPSUM WALL BOARD



TYPICAL INTERIOR PARTITION

1/2" GYPSUM WALL BOARD 2×4 WOOD STUDS @ 16" O.C. 1/2" GYPSUM WALL BOARD

(PROVIDE SOUND BATT. INSUL. IN ALL BATHROOM WALLS THAT ARE ADJACENT TO OTHER LIVING



TYPICAL INTERIOR BEARING

WALL 1/2" GYPSUM WALL BOARD 2X6 WOOD STUDS @ 16" O.C. 1/2" GYPSUM WALL BOARD



TYPICAL GARAGE INTERIOR

WALL 5/8" TYPE X GYPSUM WALL BOARD (AIR TIGHT) 1-1/4" (R5) COMFORTBOARD 80 BY ROCKWOOL 2X6 WOOD STUDS @ 16" O.C. (R24) BATT INSULATION 6MIL POLY V.B. 1/2" GYPSUM WALL BOARD



TYPICAL 8" FOUNDATION WALL PARGE EXPOSED FOUNDATION DIMPLE WRAP DRAINAGE LAYER 8" 25 MPA POURED CONCRETE FOUNDATION WALL OVER 22"X8" FOOTING (MIN. 4'-0" BELOW GRADE)



TYPICAL 10" FOUNDATION WALL PARGE EXPOSED FOUNDATION DIMPLE WRAP DRAINAGE LAYER 10" 25 MPA POURED CONCRETE FOUNDATION WALL OVER 22"X8" FOOTING (MIN. 4'-0" BELOW GRADE) (R20) BLANKET INSULATION 2×6 STUDS @ 24" O.C. 6 MIL. POLY VAPOUR BARRIER

FLOOR ASSEMBLIES



INTERIOR

TYPICAL BASEMENT CONC. FLOOR FLOOR FINISH

4" POURED CONCRETE FLOOR SLAB IOMIL VAPOUR MATT(TAPED SEAMS) 4" (MIN.) 3/4" CLEAR CRUSHED STONE COMPACTED BASE




TYPICAL WOOD FRAMED FLOOR ASSEMBLY

FLOOR FINISH SELECTED BY OWNER 3/4" PLYWOOD SUBFLOOR TJI JOISTS BY SUPPLIER 1/2" GYPSUM WALL BOARD

ROOF ASSEMBLIES



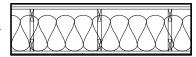


TYPICAL ASPHALT SHINGLE ROOF 30 YEAR ASPHALT SHINGLES FELT UNDERLAYMENT FULLY ADHERED WATERPROOF MEMBRANE 1/2" EXT. GRADE PLYWOOD SHEATHING ENGINEERED ROOF TRUSSES (BY OTHERS) W/ (R60) BLOWN-IN INSULATION 6 MIL. SUPER POLY V.B.

1/2" GYPSUM WALL BOARD

(INSULATION IS NOT REQUIRED IN EXTERIOR SPACE ROOFS OVER THE FRONT PORCH \$ REAR DECK)



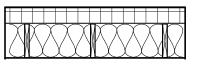

TYPICAL FLAT ROOF 2-PLY MODIFIED BITUMEN ROOF 1/2" COVER BOARD 2" (RIO) POLYISOCYANURATE RIGID INSULATION, TAPERED, JOINTS

STAGGERED \$ OVERLAPPED AIR BARRIER - SEALED AT EDGES AND PENETRAIONS 3/4" PLYWOOD SHEATHING ROOF JOISTS AS PER PLAN W/ (R30 MIN.) BATT. INSUL. BETWEEN JOISTS 12 MIL POLY VAPOUR BARRIER 1/2" GYPSUM WALL BOARD

(INSULATION NOT REQUIRED FOR OPEN EXTERIOR SPACES (COVERED DECK/PATIO)



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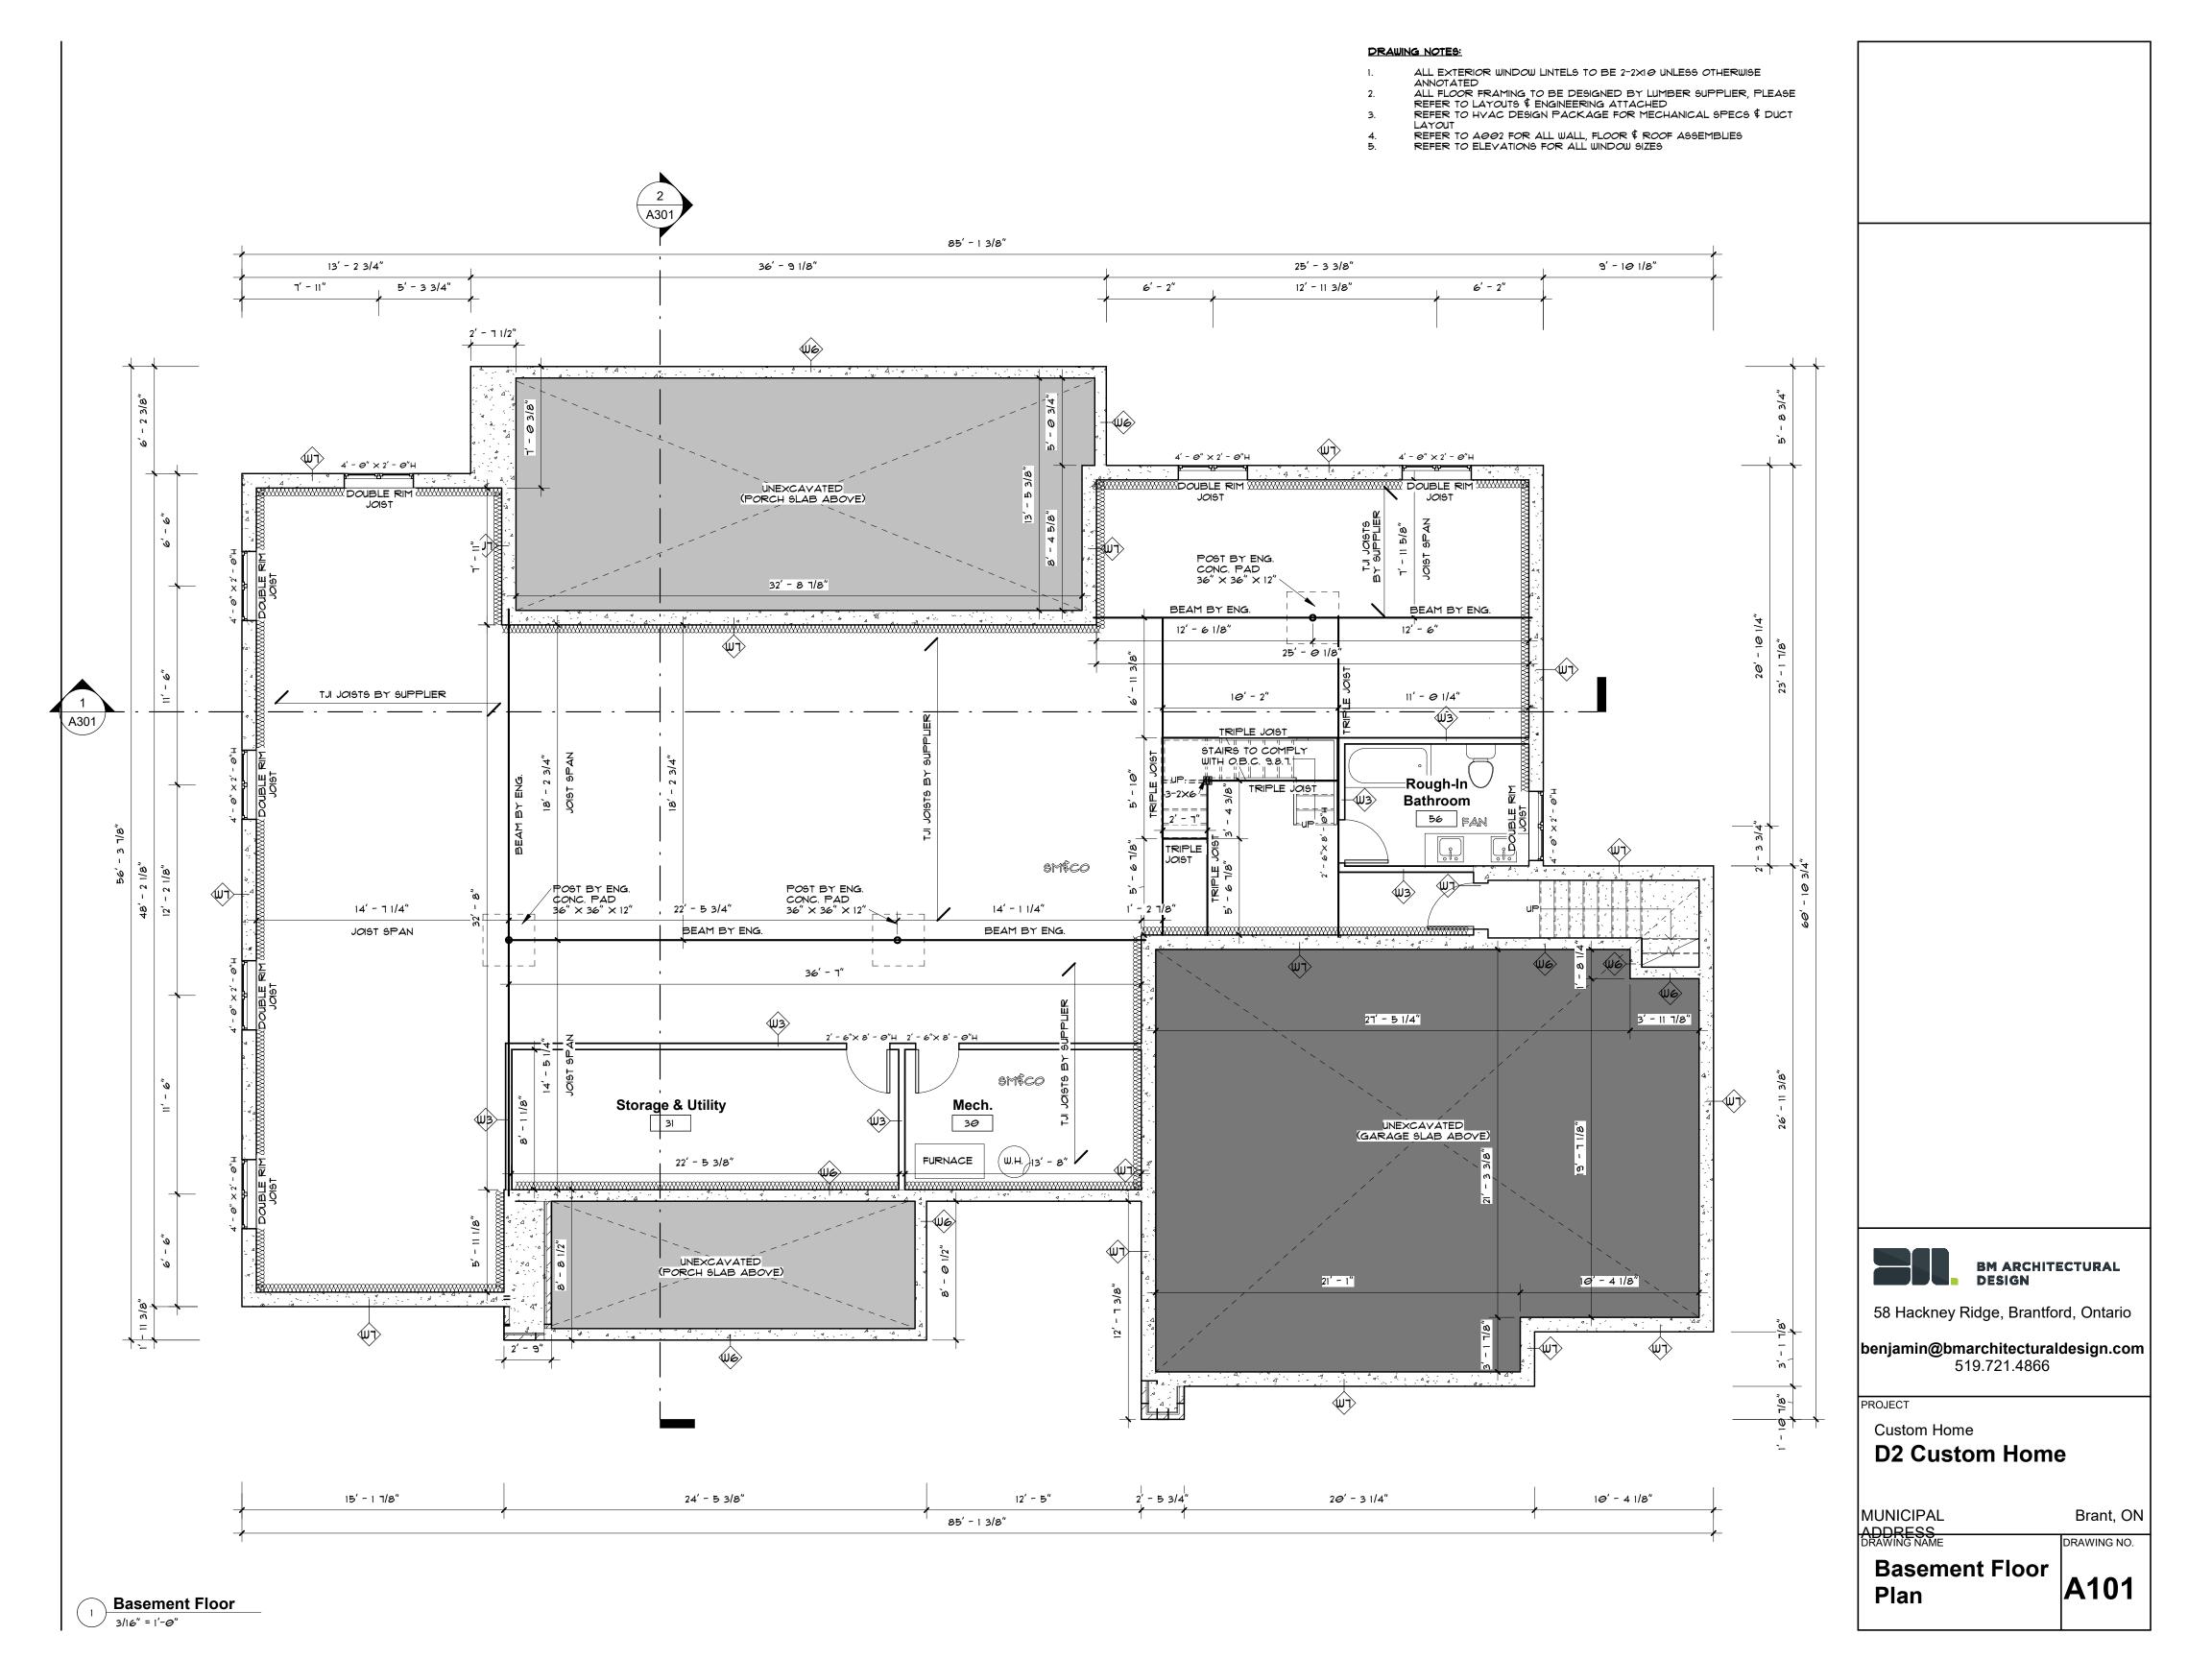
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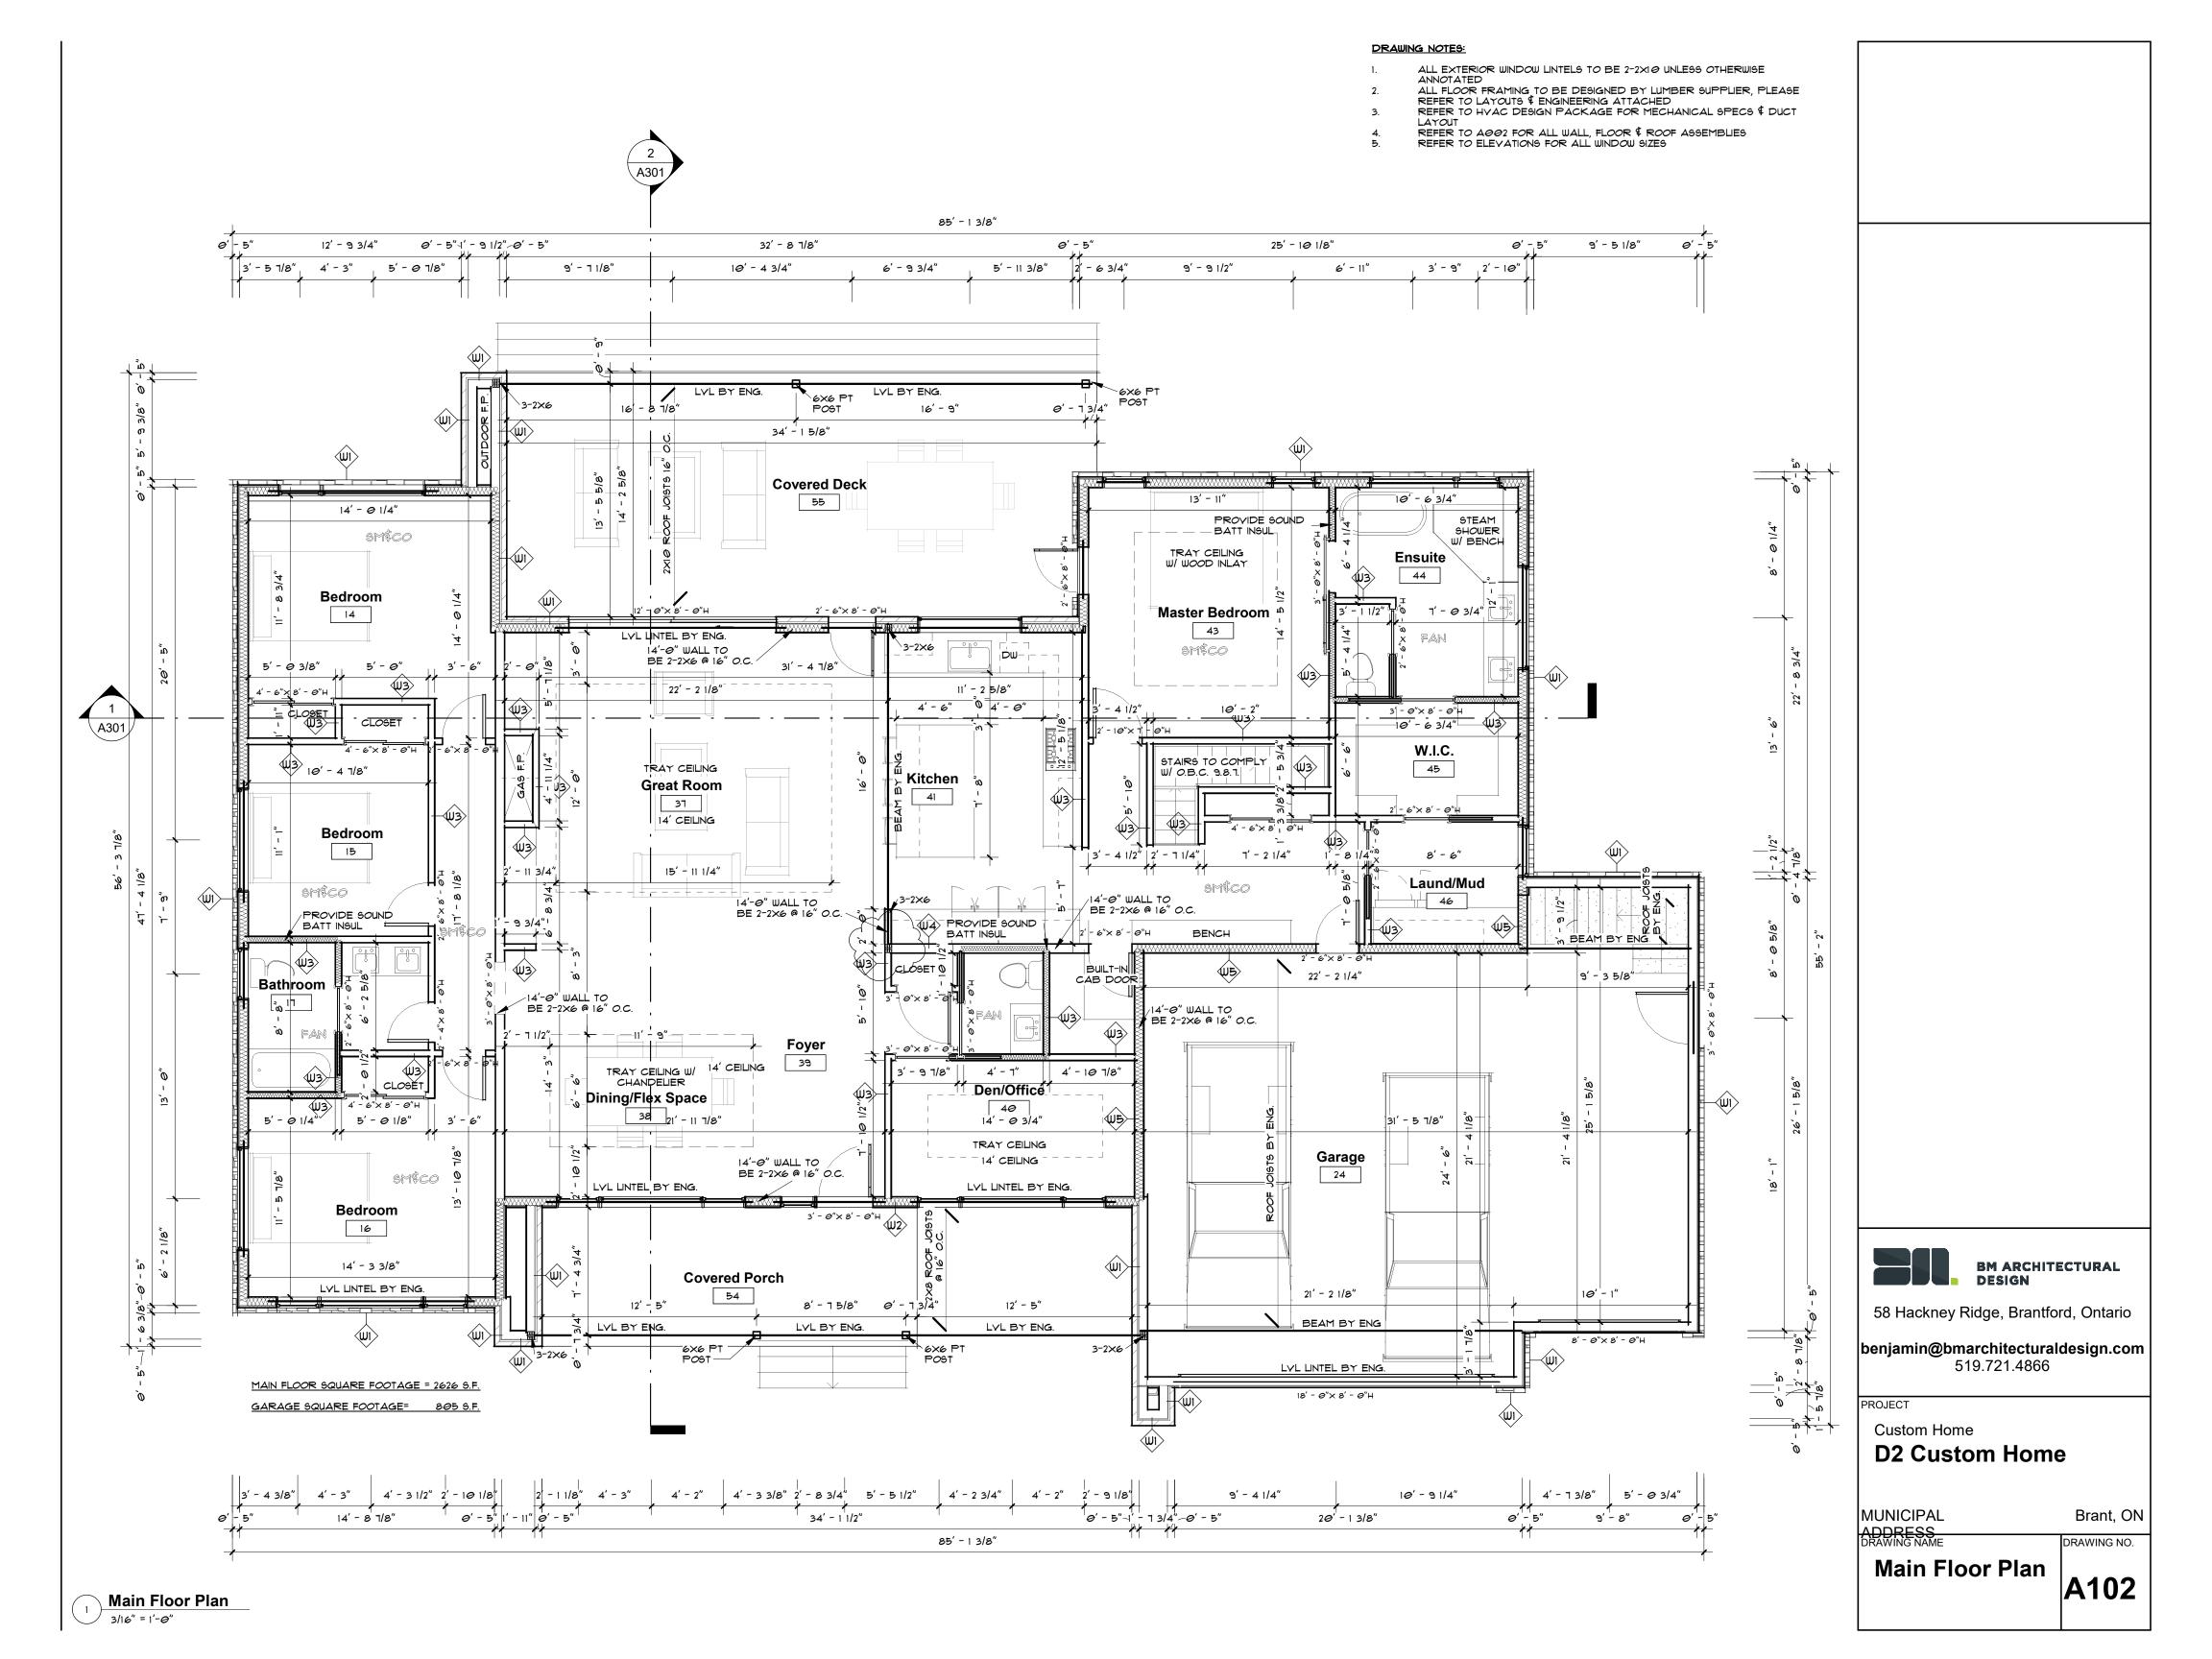
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Assemblies & Notes

A002

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DRAWING NOTES: ALL EXTERIOR WINDOW LINTELS TO BE 2-2XIO UNLESS OTHERWISE ANNOTATED ALL FLOOR FRAMING TO BE DESIGNED BY LUMBER SUPPLIER, PLEASE REFER TO LAYOUTS \$ ENGINEERING ATTACHED REFER TO HYAC DESIGN PACKAGE FOR MECHANICAL SPECS \$ DUCT REFER TO ELEVATIONS FOR ALL WINDOW SIZES TYP. FRAMED PARAPET SURROUND (8" HIGH) 0'-13/4" 2% SLOPE -TO BELOW 2% SLOPE 2% SLOPE-4" / 1'-0" 4" / 1'-0" / ENGINEERED ROOF TRUSSES @ 24" O.C. 1 3/4" / 1'-0 4" / 1'-0" ENGINEERED ROOF TRUSSES @ 24" O.C. 13/4" / 1'-0" 4" / 1'-0" 4" / 1'-0" SCUPPER TO BELOW 4" / 1'-0" 4" / 1'-0" \ TYP. FRAMED PARAPET SURROUND (8" 4 / '-'-2% SLOPE -

SCUPPER TO BELOW

TYP. FRAMED PARAPET SURROUND (8" HIGH)

2% SLOPE -



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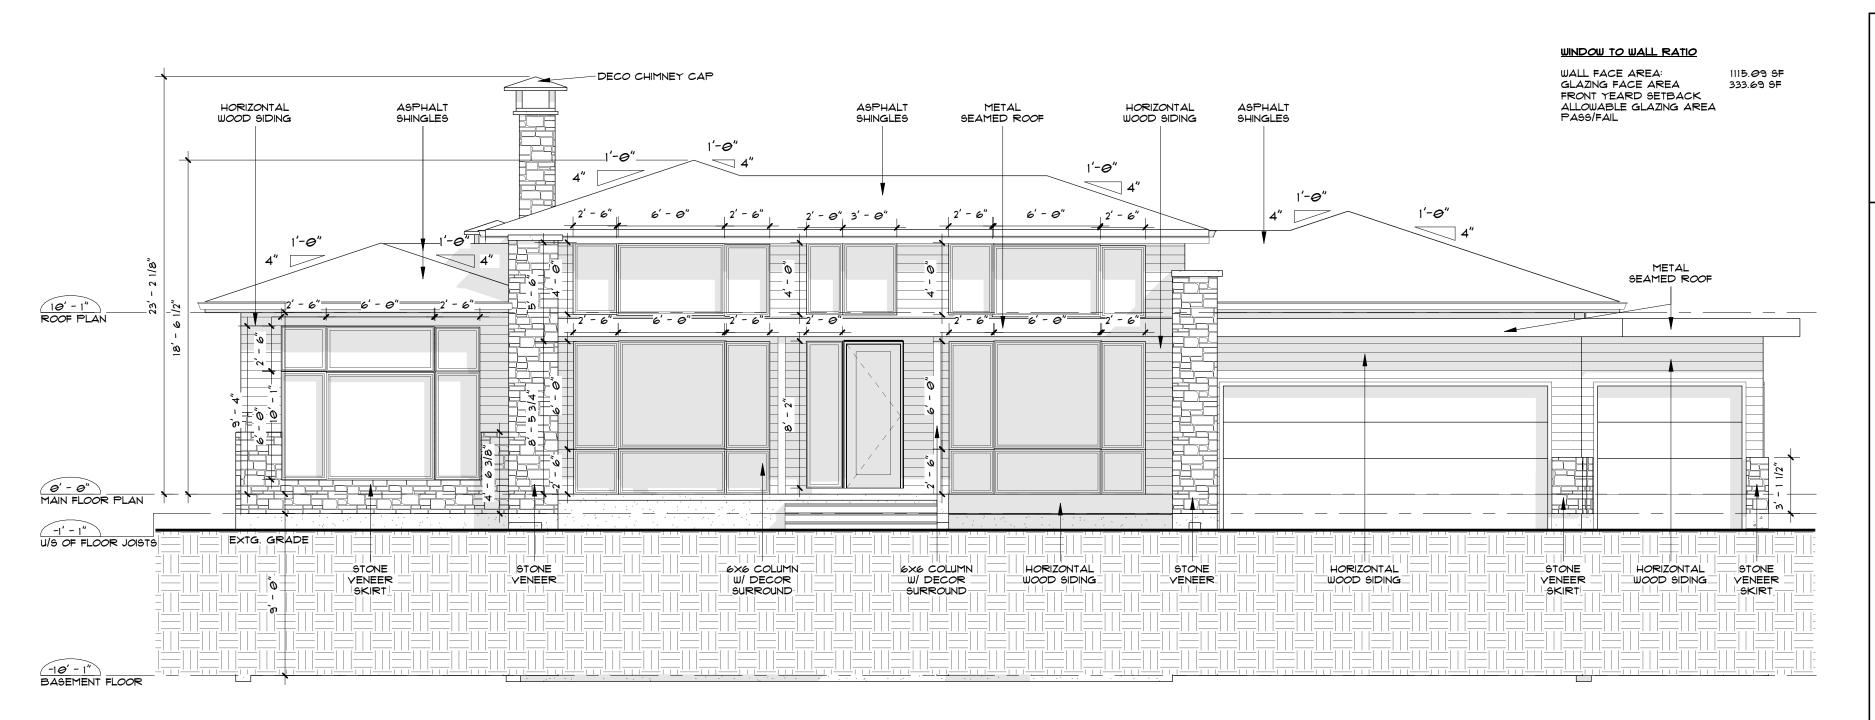
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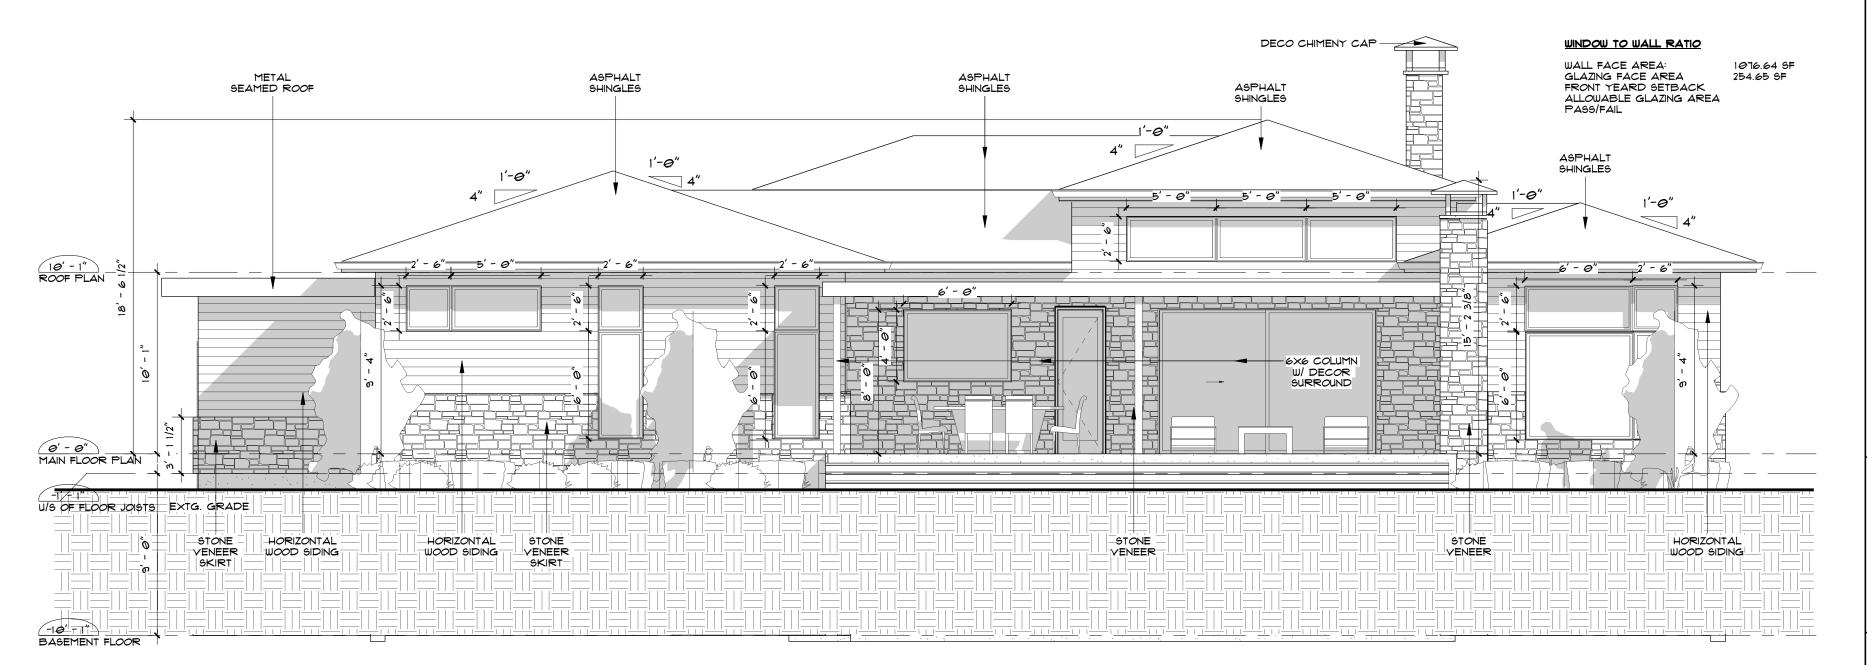
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Roof Plan



North Elevation

3/16" = 1'-9"



North



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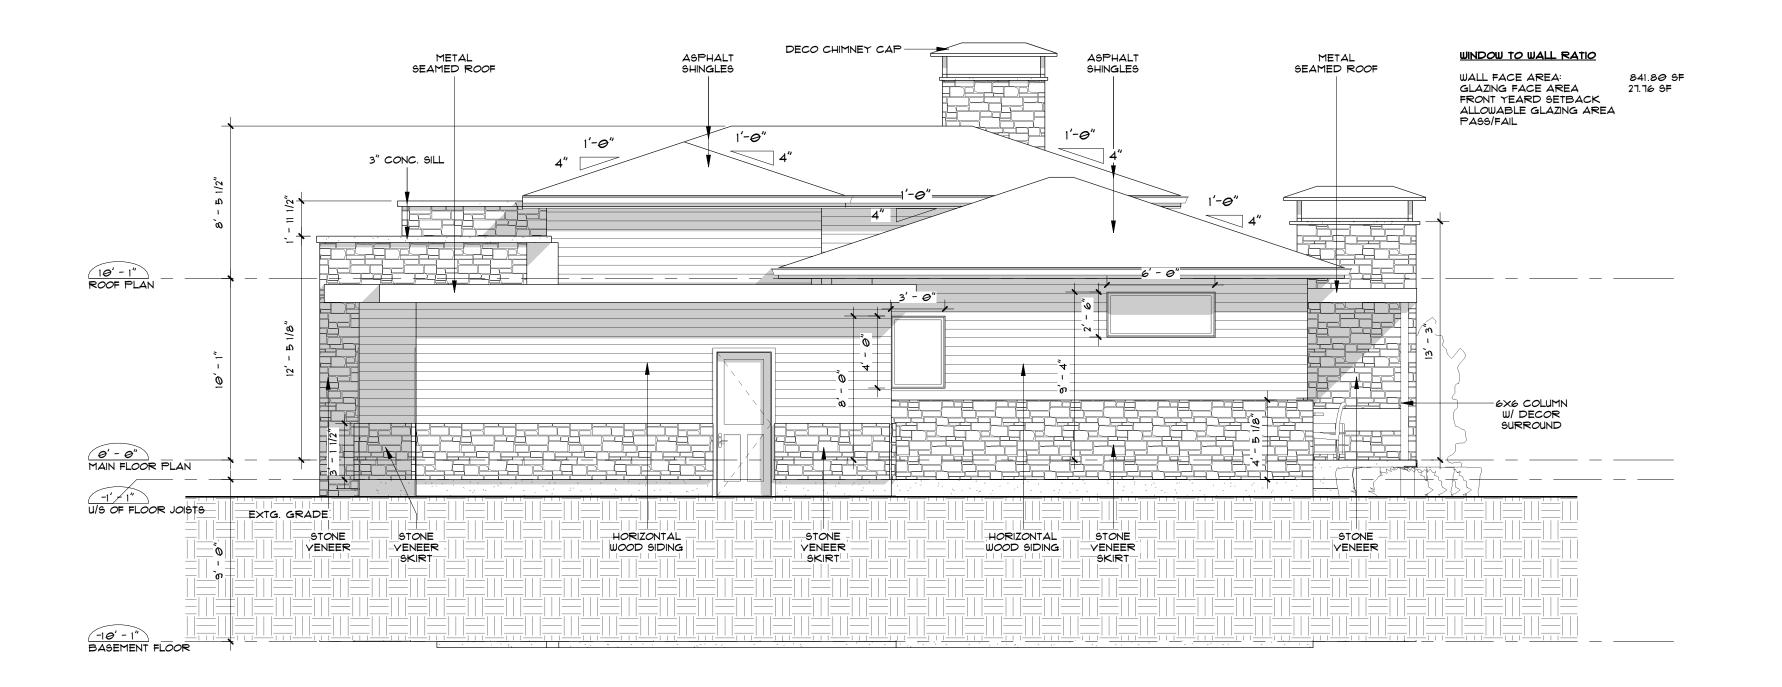
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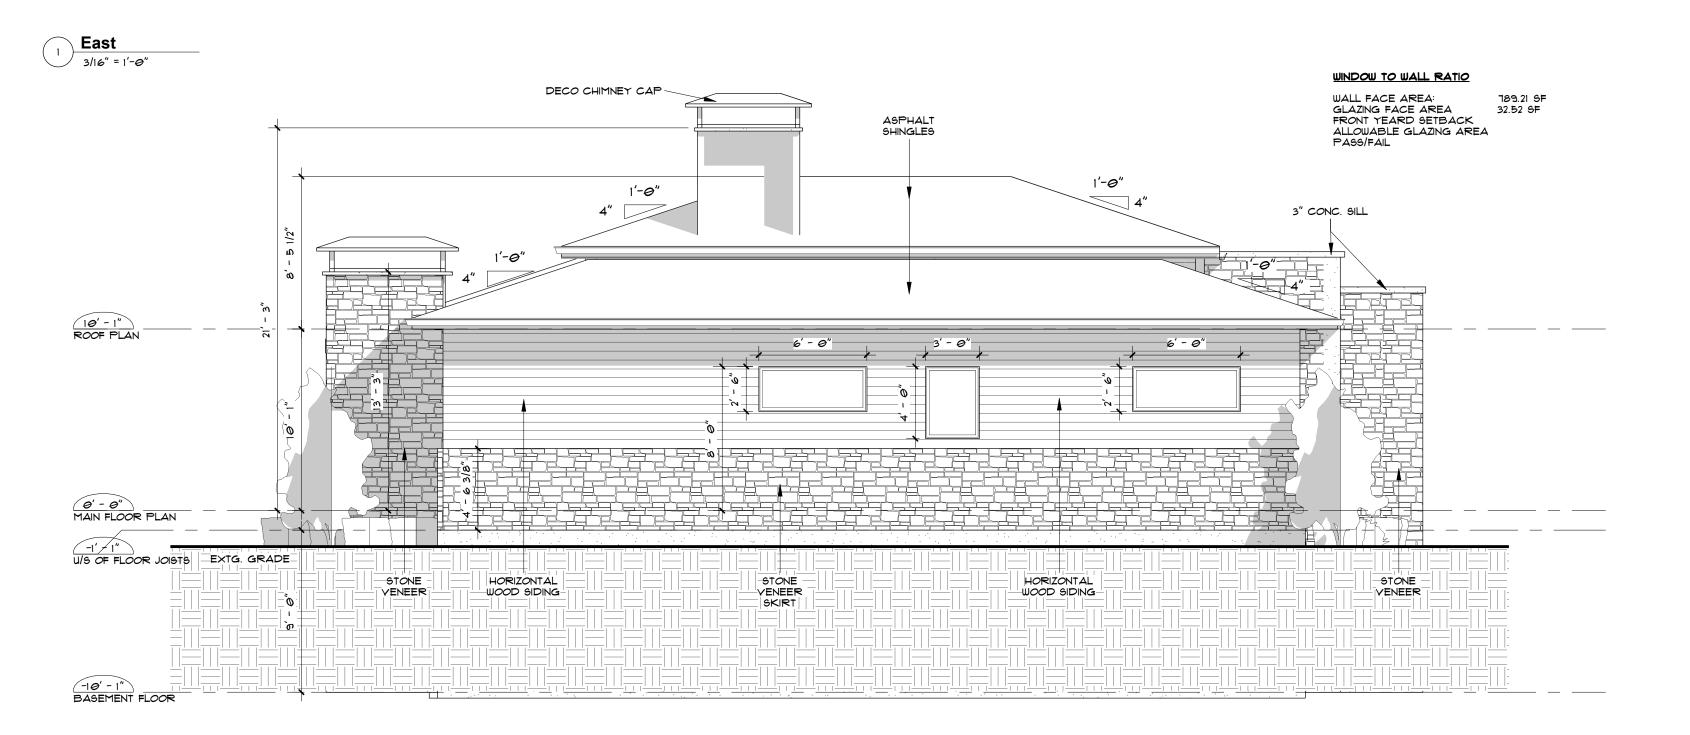
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Elevations







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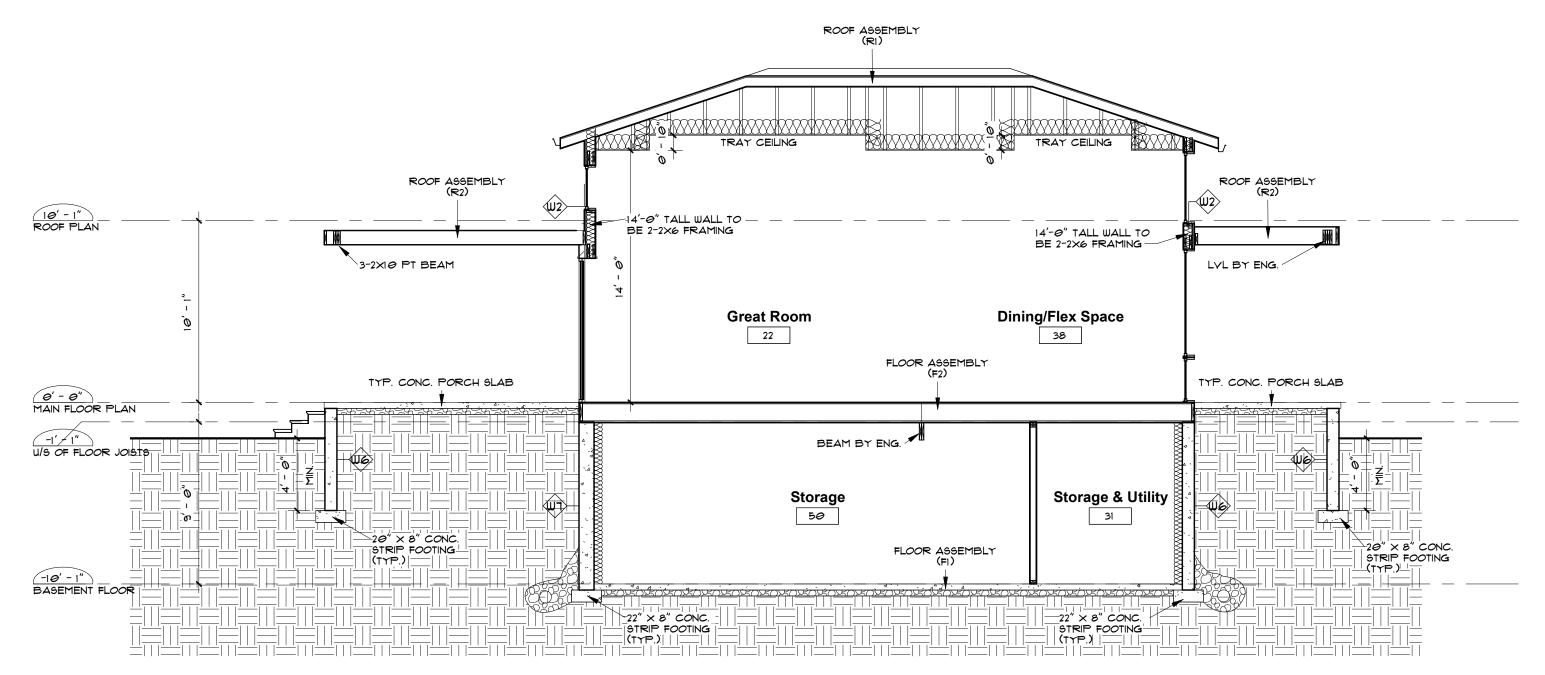
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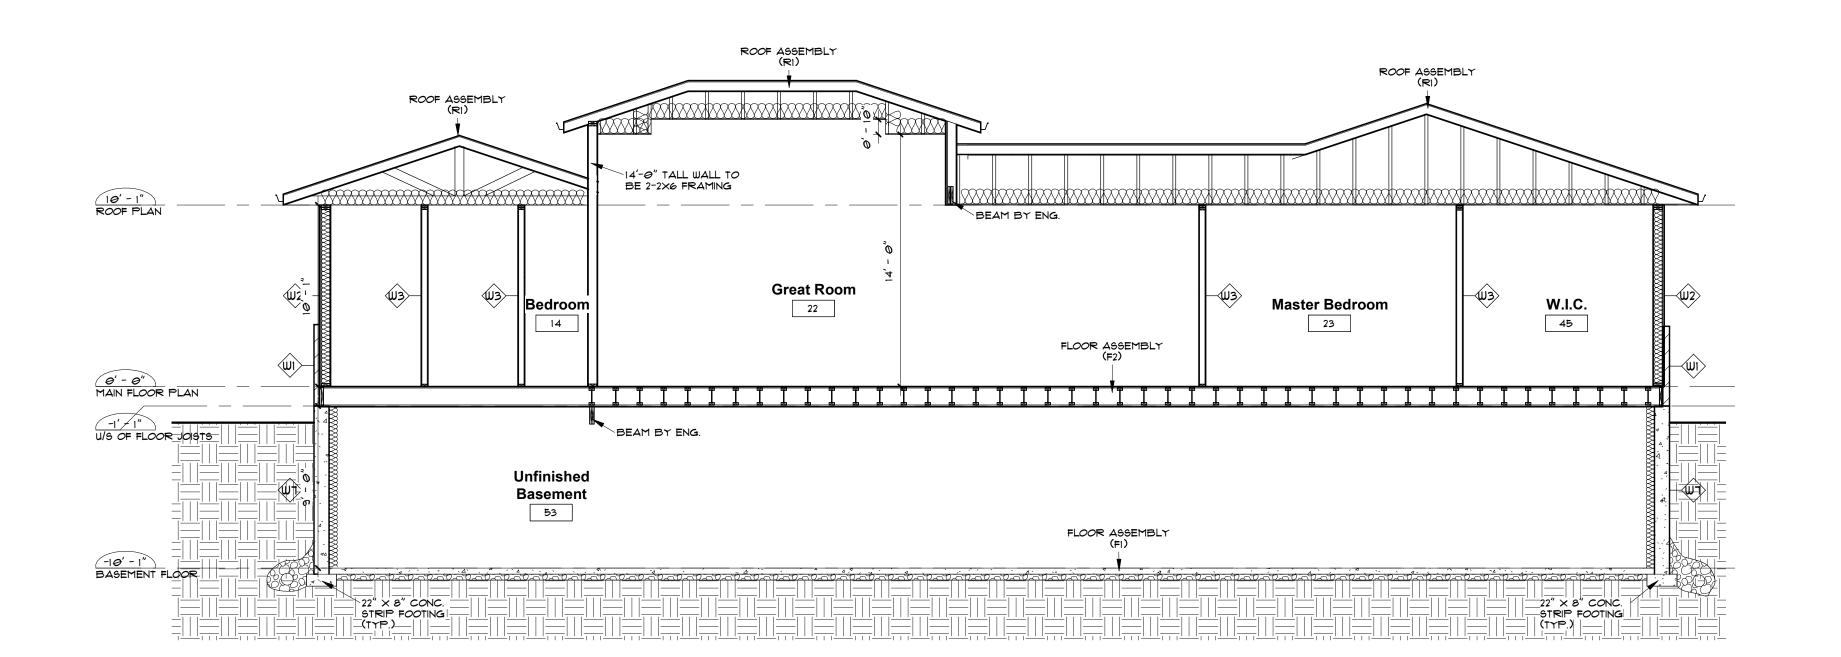
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Elevations



2 Section 2 3/16" = 1'-@"





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